



- APPROVED CYCLE FRIENDLY GRATE SHALL BE USED. THE APRON OF THE CATCHPIT MUST BE RESHAPED TO FOLLOW EXISTING ROAD SURFACE GRADING AND THE FRAME MUST NOT BE MORE THAN 5mm BELOW THE LEVEL OF THE ROAD.
- 2. WHERE EXISTING SERVICES ARE DAMAGED AS A RESULT OF TRENCHING WORK, CONTRACTOR SHALL IMMEDIATELY ADVISE ENGINEER ON SITE AND THE OWNER OF THE DAMAGED SERVICE TO ARRANGE FOR REPAIRS TO BE CARRIED OUT ON CONTRACTOR'S COST BEFORE BACKFILLING. IT IS THE CONTRACTOR RESPONSIBILITY TO IDENTIFY THE EXISTING UNDERGROUND SERVICES
- SELECTED FILL MATERIAL IS GENERALLY AP40 OR AP65, BUT IT MAY DIFFER IN CERTAIN AREAS IN ACCORDANCE WITH RCA OR OTHER REQUIREMENTS
- 4. FOR TRENCH REINSTATEMENT IN PAVEMENTS. ALL BACKFILL MATERIAL SHALL BE PLACED BACK INTO THE TRENCH IN 100-200mm THICK LAYERS AND COMPACTED USING SUITABLE COMPACTION
- 5. WHERE A TRENCH IS ON CONCRETE, ASPHALT, OR CHIPSEAL SURFACE, THE EDGE OF TRENCH SHALL BE CUT WITH A POWER SAW PRIOR TO THE EXCAVATION OF THE TRENCH. THE CUT IS TO
- EXTEND THROUGH THE FULL THICKNESS OF THE SURFACE LAYER IN A CLEAN STRAIGHT PARALLEL LINE.
 ALL BEDDING AND CUSHION MATERIAL MUST BE FREE DRAINING, NON-COMPRESSIBLE GRANULAR METRICAL.
- 7. ROAD SURFACE JOINT ARE TO BE SEALED WITH APPROVED SEALANT.
- 8. WHERE STABILISED LAYERS EXIST UNDER THE PAVEMENT, THE TRENCH SHALL BE REINSTATED WITH SIMILAR METRICAL. USING OTHER MATERIAL SHALL BE APPROVED BY THE ENGINEER.
- 9. SEE WELLINGTON WATER REGIONAL SPECIFICATION FOR WATER SERVICES DRG-01 FOR MANHOLE INSTALLATION DETAILS
- 10. SET OUT OF CATCHPIT AND CATCHPIT MANHOLES TO BE CONFIRMED BY CONTRACTOR ON SITE TO ENSURE
- (A) LOCATED AT LOW POINTS ON THE CARRIAGEWAY:
- (B) TO SUIT KERB LEVELS AND POSITION: AND
- (C) POTHOLED SERVICES
- 11. HALF BOX SUMP:(A) HALF BOX SUMP IS TO MATCH WELLINGTON CITY COUNCIL STANDARD SUMP REQUIREMENTS. ADDITIONAL REQUIREMENTS FOR HALF BOX SUMP ARE NOTED.
- (B) HALF BOX SUMP LID LEVEL IS TO BE AT LEAST 150mm LOWER THAN THE UPSTREAM INLET SUMP LID LEVEL.
- (C) ALL CONNECTIONS TO THE HALF BOX SUMP SYSTEM ARE TO BE SEALED.
- 12. SUMPS ARE TO BE INSTALLED IN ACCORDANCE WITH WELLINGTON CITY COUNCIL'S CODE OF PRACTICE

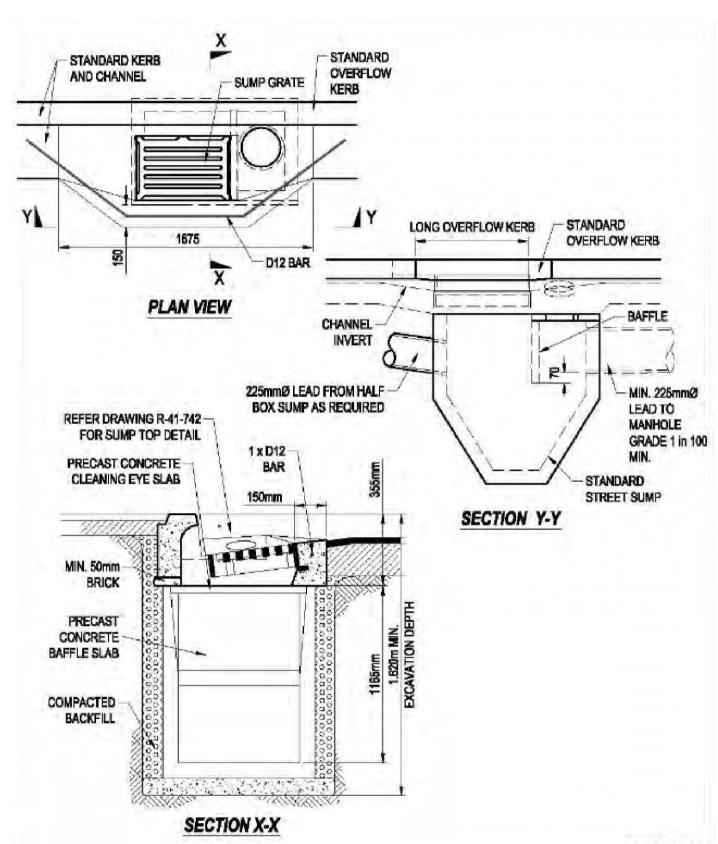


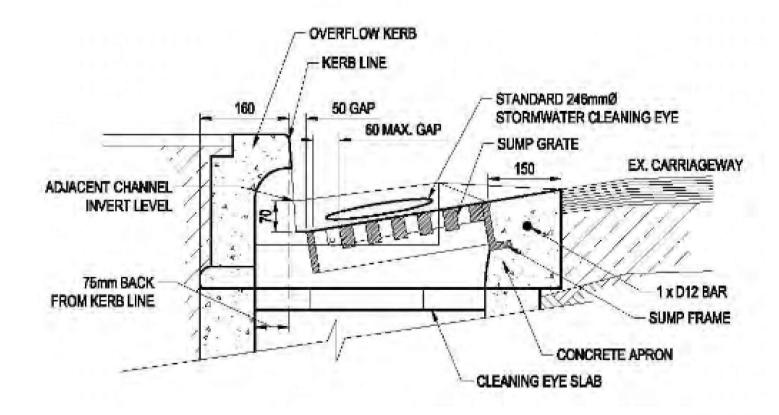



REFER TO PLAN NO. R-41-742 IN WCC CODE OF PRACTICE FOR LAND DEVELOPMENT FOR DETAILS




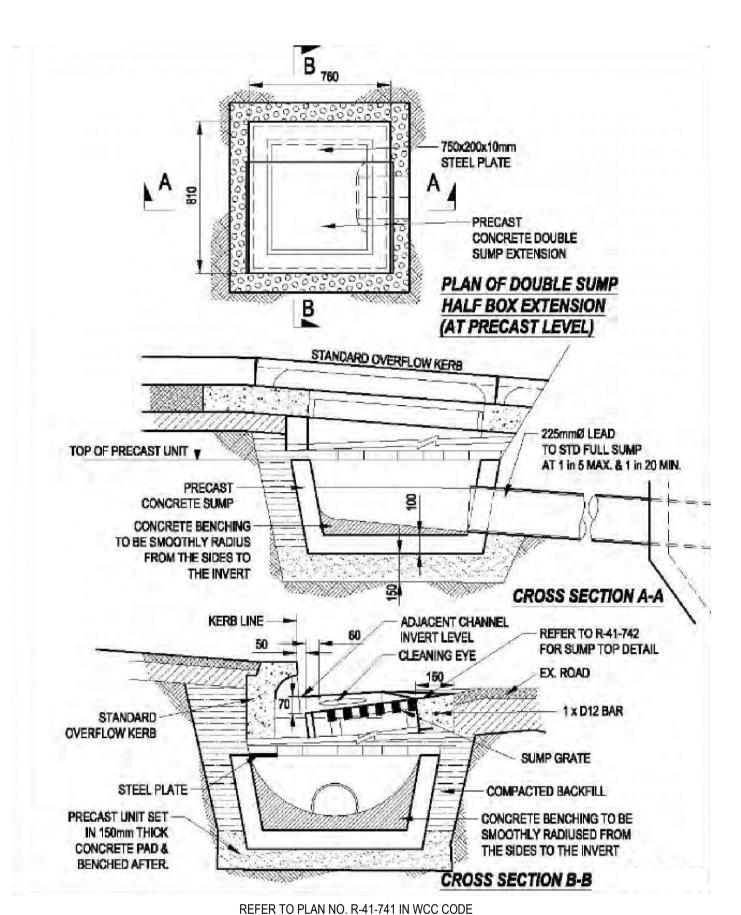


OF PRACTICE FOR LAND DEVELOPMENT FOR DETAILS

WCC HALF BOX SUMP EXTENSION AND SECTION


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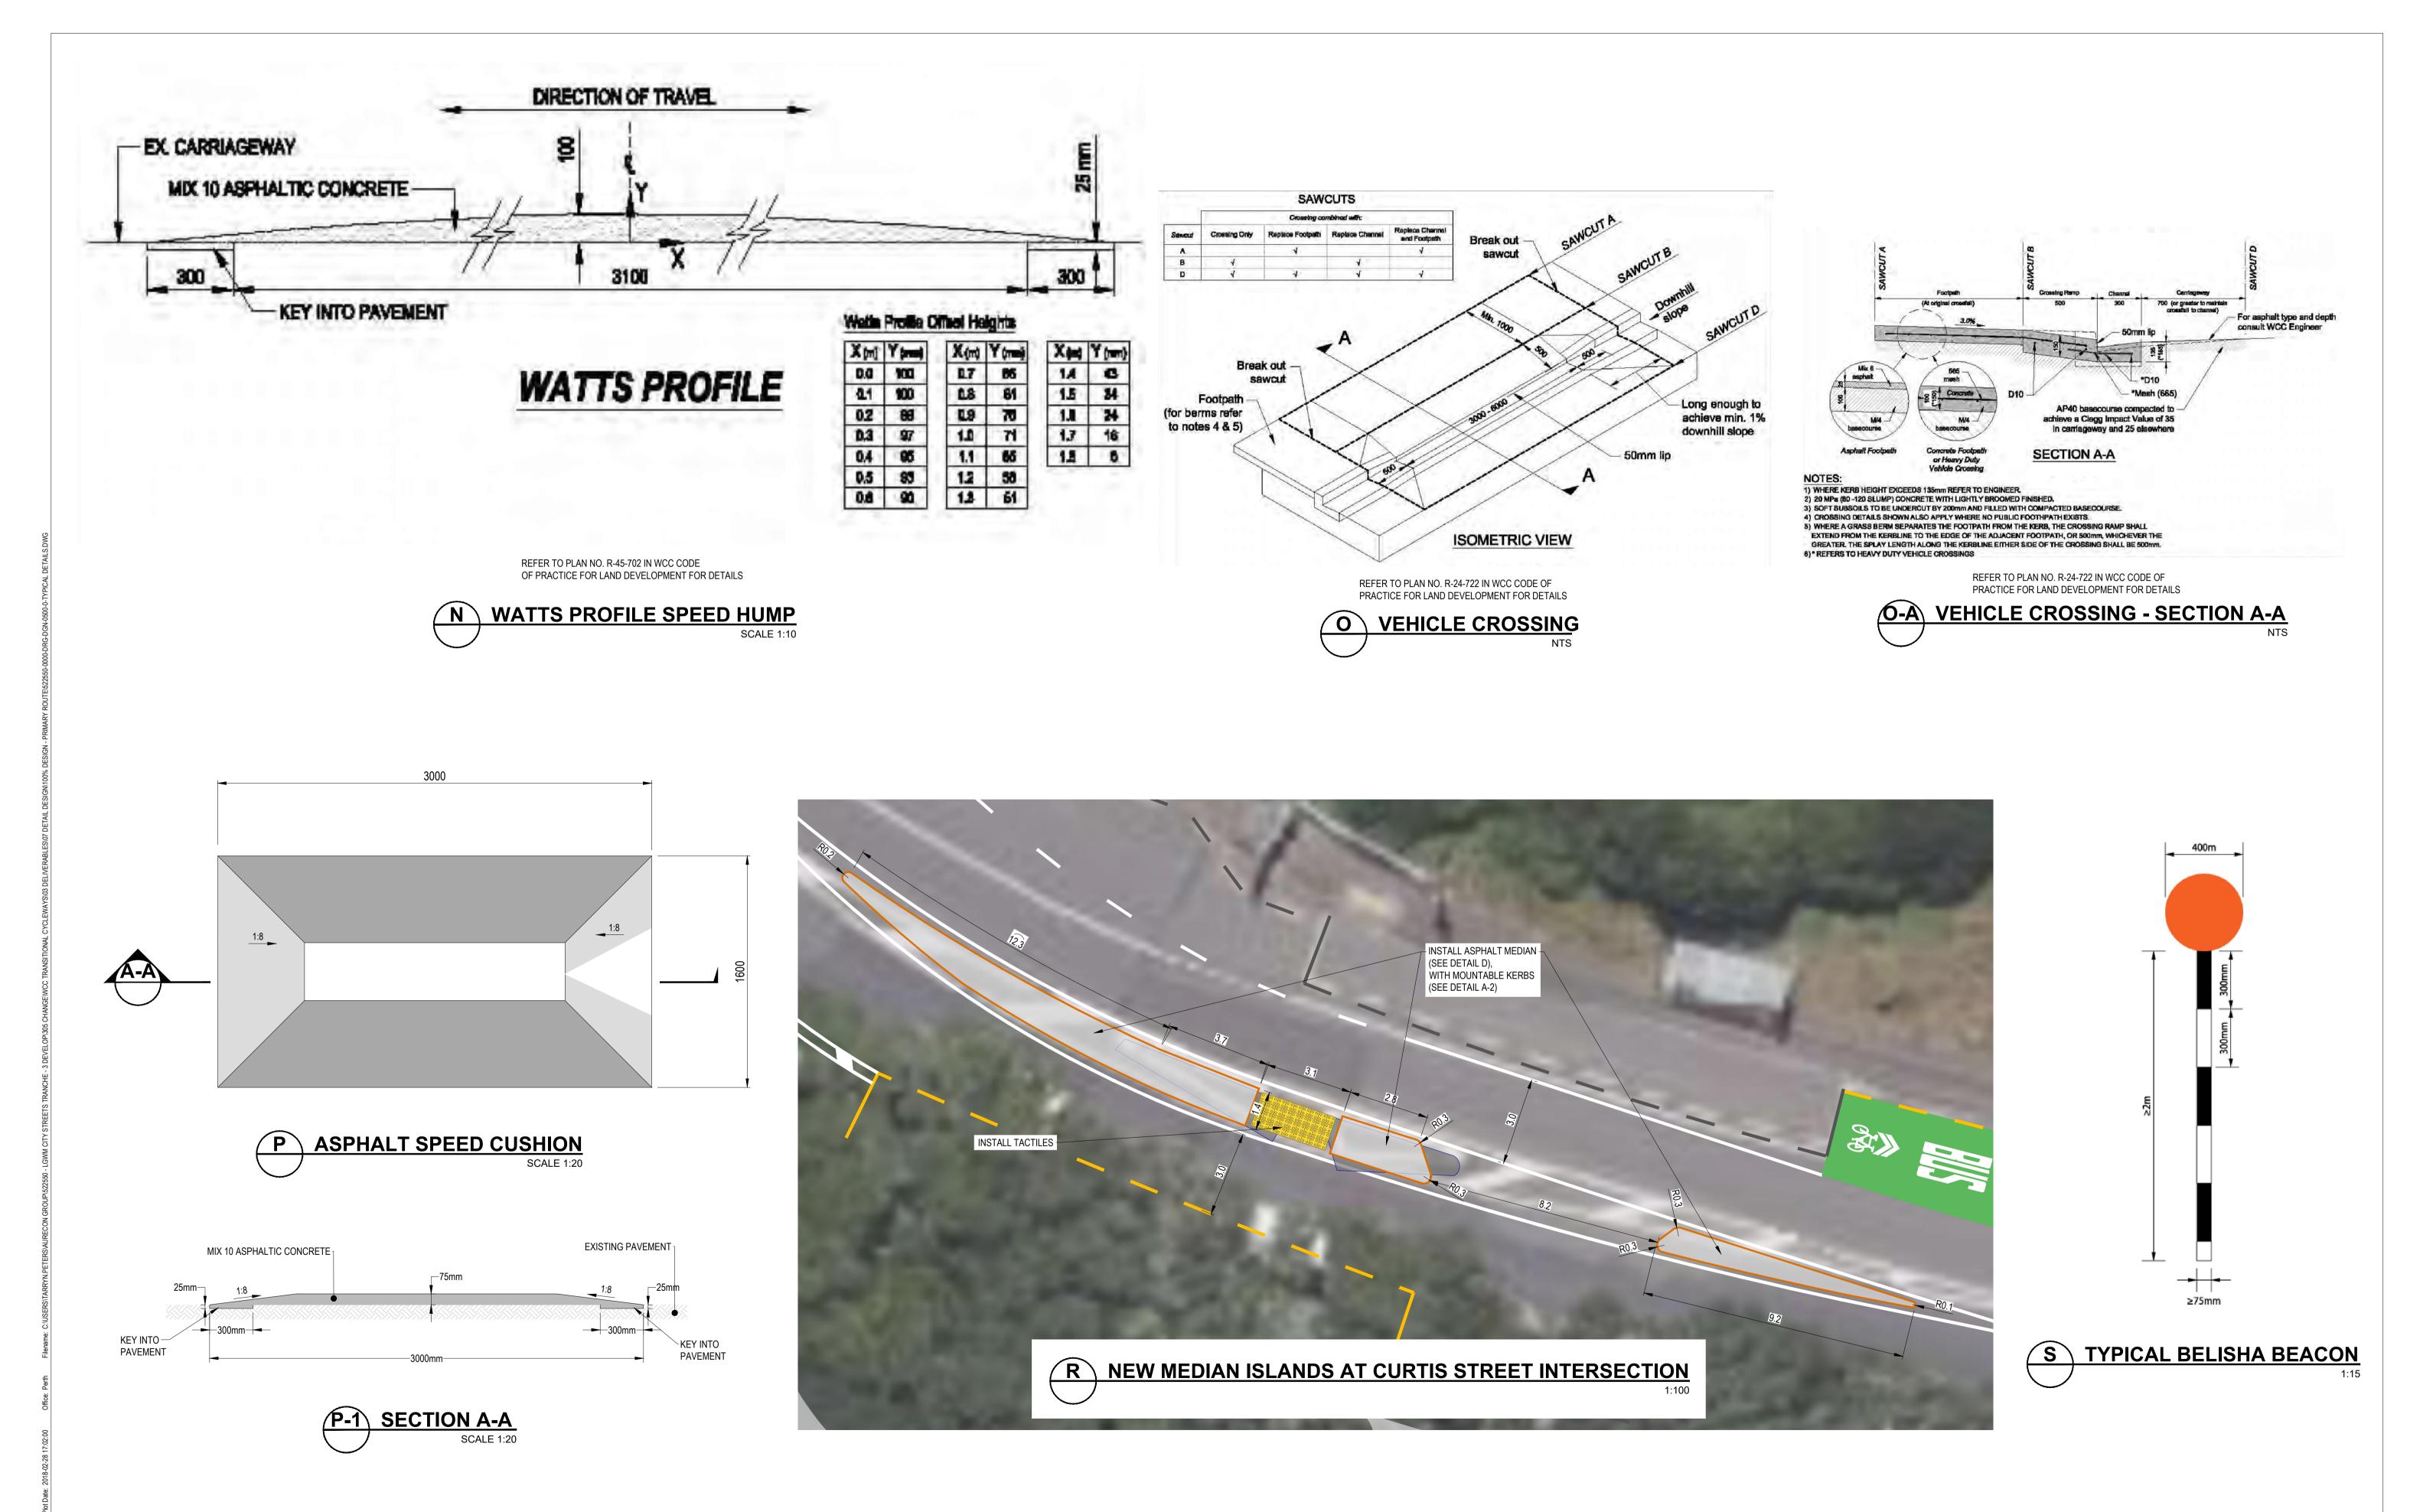


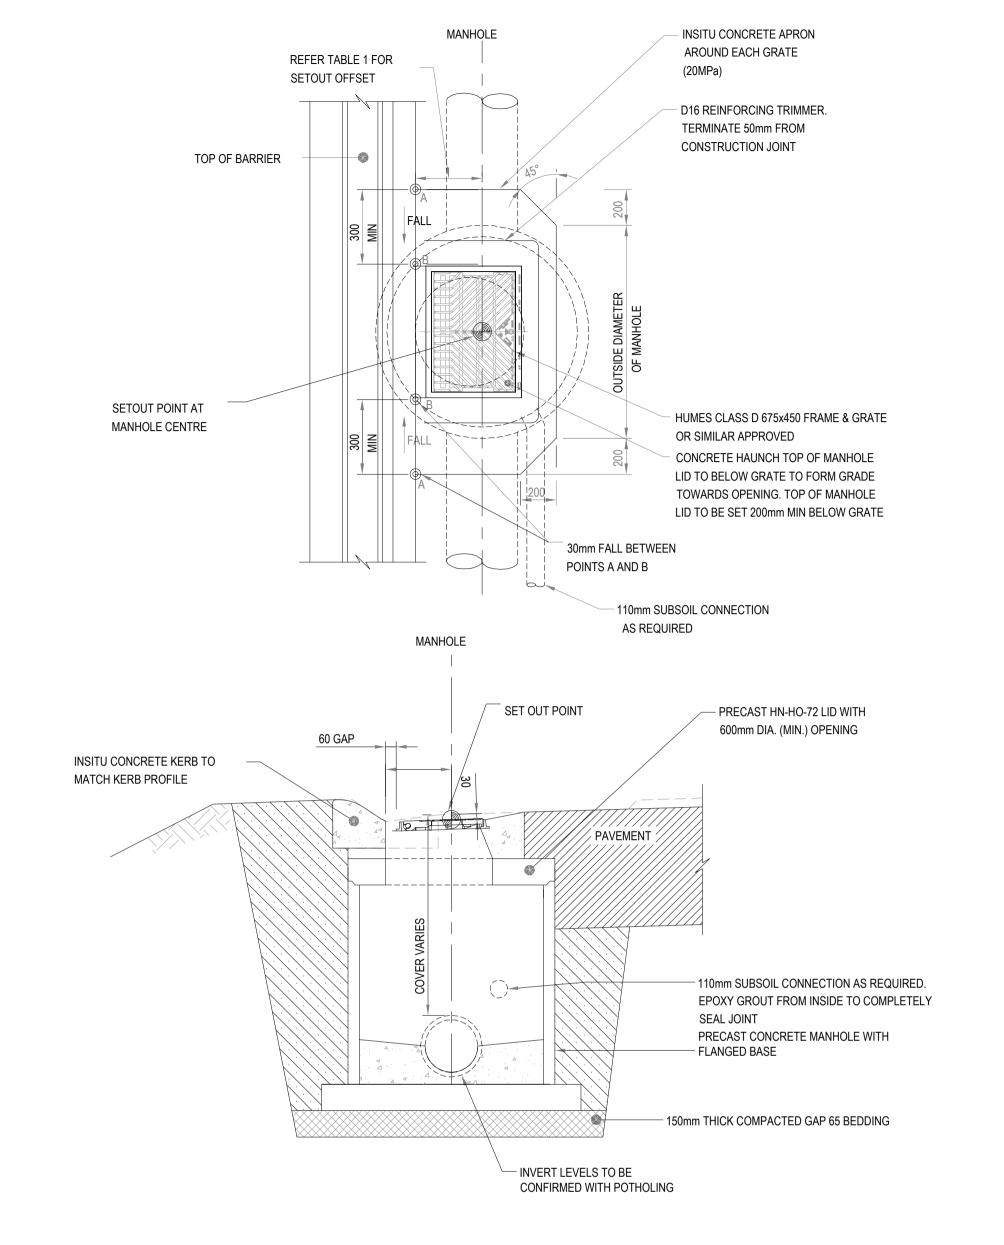

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_	REVISION DETAILS FOR CONSTRUCTION	APPROVED G MURISON	SCALE AS SHOWN	SIZE A1	FOR CONSTRUCTION	PROJECT	KARORI TO BOTANIC GARDEN KI PAEKAKA CONNECTION WCC TRANSITIONAL CYCLEWAYS			DNS	
			A IBRAHIM		APPROVED DATE	SUMPS, HALF BOX SUMP TITLE TYPICAL DETAILS					
			DESIGNED A IBRAHIM REVIEWED				PRIMARY ROUTE - 100% DESIGN I			RE	
			S HAMILTON			DRAWING No.	522550 - 0000	- DRG - DG	N - 0505	- 0	

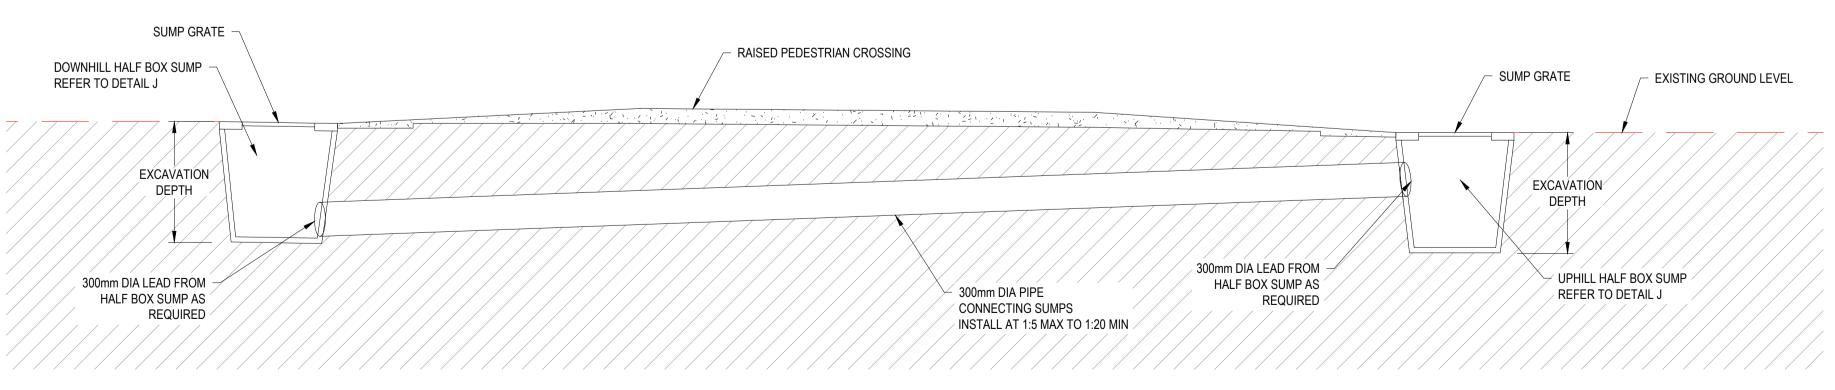



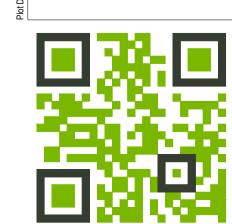

Absolutely Positively Wellington City Council
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/	DATE	REVISION DETAILS	APPROVED	SCALE	S
	15/12/23	FOR CONSTRUCTION	G MURISON	AS SHOWN	
				DRAWN	
				T PETERS	
				DESIGNED	
				T PETERS	
				REVIEWED	
				S HAMILTON	

F	FOR CONSTRUC	CTION	PF
	APPROVED	DATE	Τľ

KARORI TO BOTANIC GARDEN KI PAEKAKA CONNECTIONS
WCC TRANSITIONAL CYCLEWAYS

WATTS SPEED HUMP, VEHICLE CROSSING, SPEED CUSHION
TYPICAL DETAILS
PRIMARY ROUTE - 100% DESIGN IFC

PROJECT NO. AREA TYPE DISC NUMBER REV
DRAWING NO. 522550 - 0000 - DRG - DGN - 0506 - 0

GENERAL NOTES:

- 1. ALL DIMENSIONS ON PLANS ARE IN METRES (m) UNLESS OTHERWISE NOTED ON THE DRAWINGS.
- 2. ALL DIMENSIONS ON THE DETAIL SHEETS ARE IN MILLIMETRES (mm) UNLESS OTHERWISE NOTED.
- 3. ALL COORDINATES ARE IN NEW ZEALAND GEOTECHNICAL DATABASE NZGD2000
- 4. LIGHTING DRAWINGS ARE TO BE READ IN CONJUNCTION WITH ALL OTHER DISCIPLINE DRAWINGS AND DETAILS.

LIGHTING DESIGN:

- 1. THE BOTANIC GARDENS PEDESTRIAN FOOTPATH HAS BEEN DESIGNED TO CATEGORY PR3.
- 2. THE LIGHTING DESIGN HAS BEEN CARRIED OUT USING AGi32 LIGHTING ANALYSIS SOFTWARE VERSION 20.6.

STANDARDS:

THE FOLLOWING RELEVANT STANDARDS HAVE BEEN USED AS THE BASIS FOR THE DESIGN DEVELOPMENT:

- 1. AS/NZS 1158.3.1:2020 LIGHTING FOR ROADS AND PUBLIC SPACES, PART 3.1 PEDESTRIAN AREA (CATEGORY P) LIGHTING -PERFORMANCE AND DESIGN REQUIREMENTS.
- 2. AS/NZS 4282:2019 CONTROL OF THE OBTRUSIVE EFFECTS OF OUTDOOR LIGHTING.
- 3. AS/NZS 3000:2018 ELECTRICAL INSTALLATIONS.
- 4. WAKA KOTAHI NEW ZEALAND TRANSPORT AGENCY M30 ACCEPTED LUMINAIRES OCTOBER 2022.
- 5. WAKA KOTAHI NEW ZEALAND TRANSPORT AGENCY M26 SPECIFICATION FOR COLUMN LIGHTING 2012

NOTES:

1. ALL NEW LIGHTING EQUIPMENT IS TO BE INSTALLED WITH THE OUTREACH AND LUMINAIRE ORIENTED PERPENDICULAR TO THE PEDESTRIAN PATHWAY IN ITS INSTALLED LOCATION.

CONTRACTOR RESPONSIBILITIES:

- WHILE ALL DUE CARE IS UNDERTAKEN TO ENSURE THAT ALL SERVICES ARE SPATIALLY COORDINATED, IT IS
 THE CONTRACTORS RESPONSIBILITY TO ENSURE THAT ALL SERVICES ARE COORDINATED UPON
 INSTALLATION WHERE UNFORESEEN SITE CONSTRAINTS ARISE.
- 2. ALL LIGHTING SYSTEMS SHALL BE INSTALLED AS SPECIFIED WITHIN THIS LIGHTING PACKAGE. FOR ANY PROPOSED CHANGES BY THE CONTRACTOR, IT IS THEIR RESPONSIBILITY TO ENSURE THAT THE DESIGN IS COMPLIANT WITH ALL RELEVANT STANDARDS.
- 3. ALL OUTREACH ARMS ARE TO BE OF A NEW ZEALAND TRANSPORT AGENCY TYPE APPROVED COLUMN.
- 4. EXISTING TIMBER AND COLUMNS ARE OF VERYING HEIGHTS. THE CONTRACTOR SHALL PROCURE SUITABLE OUTREACH ARMS FOR EACH TO ACHIEVE A 10m LUMINAIRE MOUNTING HEIGHT FOR EACH.
- 5. ALL NEW LUMINAIRES ARE TO BE SUPPLIED VIA AN EXTENSION OF THE EXSITING OVERHEAD POWER. THE CONTRACTOR SHALL ALLOW FOR ALL FIXINGS, FITTINGS AND SUNDRY EQUIPMENT TO ALLOW FOR SECURE EXTENSION OF THE EXISTING OVERHEAD POWER.
- 6. IT IS THE CONTRACTORS RESPONSIBILITY TO ENGAGE WITH A SUITABLY QUALIFIED ARBORIST TO CONFIRM THE SUITABILITY OF THE OVERHEAD WIRING RETICULATION THROUGH THE EXISTING TREE CANOPIES. THE CONTRACTOR IS TO ALLOW FOR ANY STRUCTURAL PRUNING REQUIRED TO ACHIEVE A SAFE CABLE RETICULATION.
- 7. IT IS THE CONTRACTORS RESPONSIBILITY TO COORDINATE ALL CONNECTION APPLICATIONS / CHANGE OF CONNECTION DETAILS AND THE LIKE WITH THE ENERGY AUTHORITY.

LEGEND

NEW LUMINAIRE AND OUTREACH ARM MOUNTED TO NEW 10m TIMBER COLUMN

NEW LUMINAIRE AND OUTREACH ARM MOUNTED ON EXISTING TIMBER / CONCRETE COLUMN

XX LUMINAIRE ID

X COLUMN UNIQUE IDENTIFIER

TABLE 1: COLUMN SCHEDULE

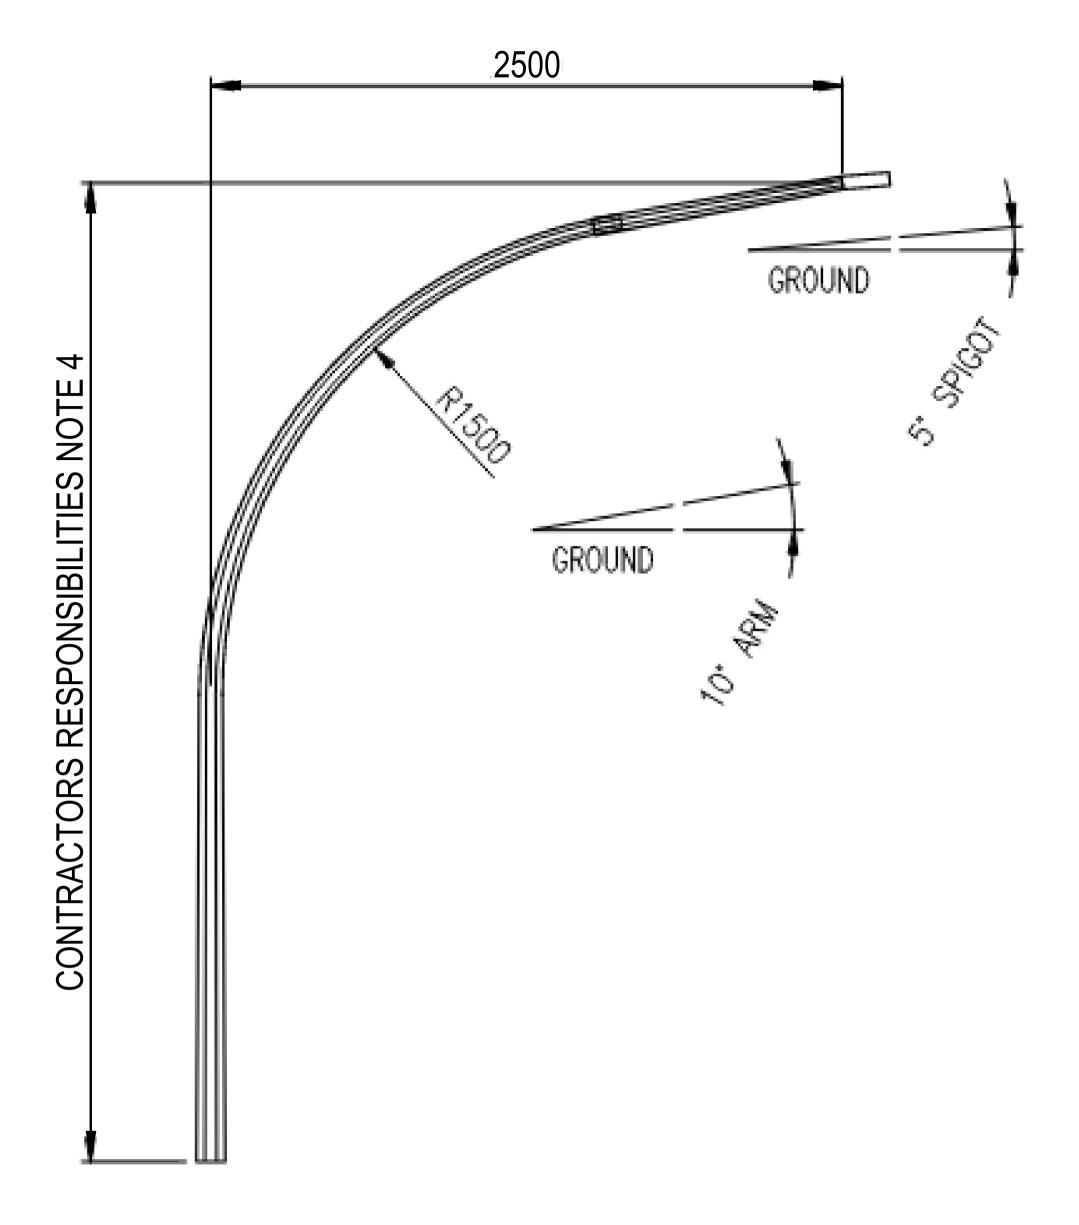
COLUMN ID	DESCRIPTION	HEIGHT	O/REACH	COLUMN TYPE	LUMINAIRE	FOOTING	EASTING	NORTHING	ASSET OWNER
01	NEW LUMINAIRE AND OUTREACH ON EXISTING COLUMN	10m	2.5m	TIMBER	PECAN LIGHTING NXT 72M	BURIED IN-GROUND	1746828.33	5428158.85	WELLINGTON CITY COUNCIL
02	NEW LUMINAIRE AND OUTREACH ON NEW COLUMN	10m	2.5m	TIMBER	PECAN LIGHTING NXT 72M	BURIED IN-GROUND	1746864.57	5428146.48	WELLINGTON CITY COUNCIL
03	NEW LUMINAIRE AND OUTREACH ON NEW COLUMN	10m	2.5m	TIMBER	PECAN LIGHTING NXT 72M	BURIED IN-GROUND	1746895.49	5428125.78	WELLINGTON CITY COUNCIL
04	NEW LUMINAIRE AND OUTREACH ON NEW COLUMN	10m	2.5m	TIMBER	PECAN LIGHTING NXT 72M	BURIED IN-GROUND	1746916.51	5428093.75	WELLINGTON CITY COUNCIL
05	NEW LUMINAIRE AND OUTREACH ON EXISTING COLUMN	10m	2.5m	TIMBER	PECAN LIGHTING NXT 72M	BURIED IN-GROUND	1746922.51	5428055.78	WELLINGTON CITY COUNCIL
06	NEW LUMINAIRE AND OUTREACH ON EXISTING COLUMN	10m	2.5m	CONCRETE	PECAN LIGHTING NXT 72M	BURIED IN-GROUND	1746922.47	5428023.43	WELLINGTON CITY COUNCIL
07	NEW LUMINAIRE AND OUTREACH ON EXISTING COLUMN	10m	2.5m	CONCRETE	PECAN LIGHTING NXT 72M	BURIED IN-GROUND	1746922.72	5427982.08	WELLINGTON CITY COUNCIL

TABLE 2: LUMINAIRE SCHEDULE


ITEM TYPE	IMAGE	DESCRIPTIONS	CONSTRUCTION	COLOUR	DIMENSION	SUITE	CAT. NO.	SUPPLIER	LAMP	CONTROL	MOUNTING	CONTACT	NOTES
						EMU DEPO	T RAIL YARD LUI	MINAIRES					
L1		POST TOP LUMINAIRE	DIE CAST ALUMINIUM IP66 / IK09	GREY	L 465mm x W 237mm x H 134mm	NXT-M	NXT-72M-2-7-4 AH-7-G-4-CZ-D -2H	PECAN LIGHTING	158W LED 4000K OPTIC: ANZ HIGH-THROW	INTEGRAL ELECTRONIC DALI DIMMABLE DRIVER	OUTREACH ARM MOUNTED	MIKE GEDDIS ENERGYLIGHT 0421 514 102	- SUPPLIED COMPLETE WITH NEMA CELL TO NZTA SPECIFICATIONS.

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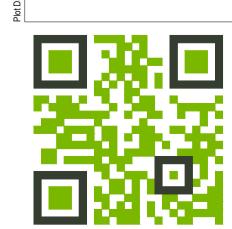
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Q TYPICAL OCTAGONAL CURVED OUTREACH ARM
NTS



Q-1 APPLETON PARK TYPICAL CROSS SECTION
SCALE 1:25



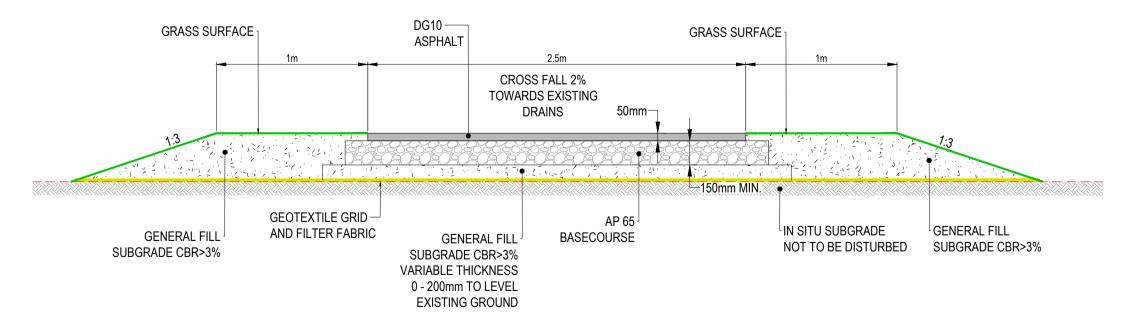

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DATE	REVISION DETAILS	APPROVED
15/12/23	FOR CONSTRUCTION	G MURISON
15/03/24	FOR CONSTRUCTION	G MURISON
27/03/24	FOR CONSTRUCTION	G MURISON

SCALE SIZE AS SHOWN A1

DRAWN
T PETERS
DESIGNED
T PETERS
REVIEWED

FOR CONSTRUCTION
APPROVED

APPROVED

DATE

S HAMILTON

